



SECTION A-A
SCALE 1:50

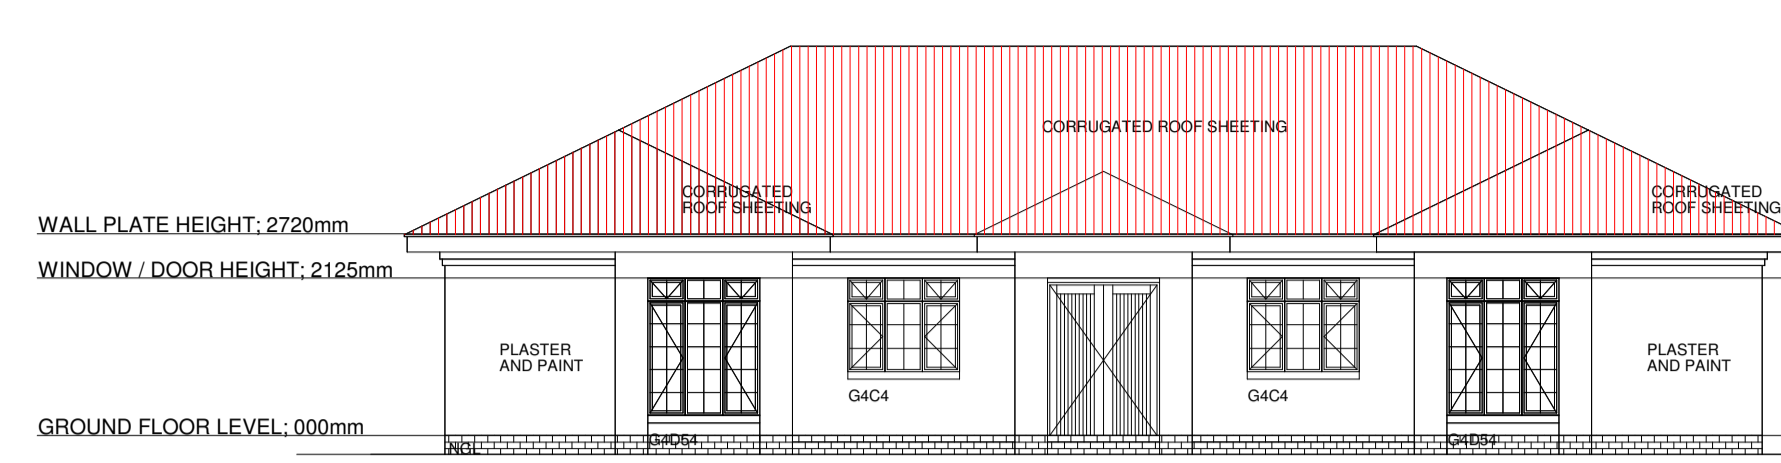


FRONT ELEVATION
SCALE 1:100

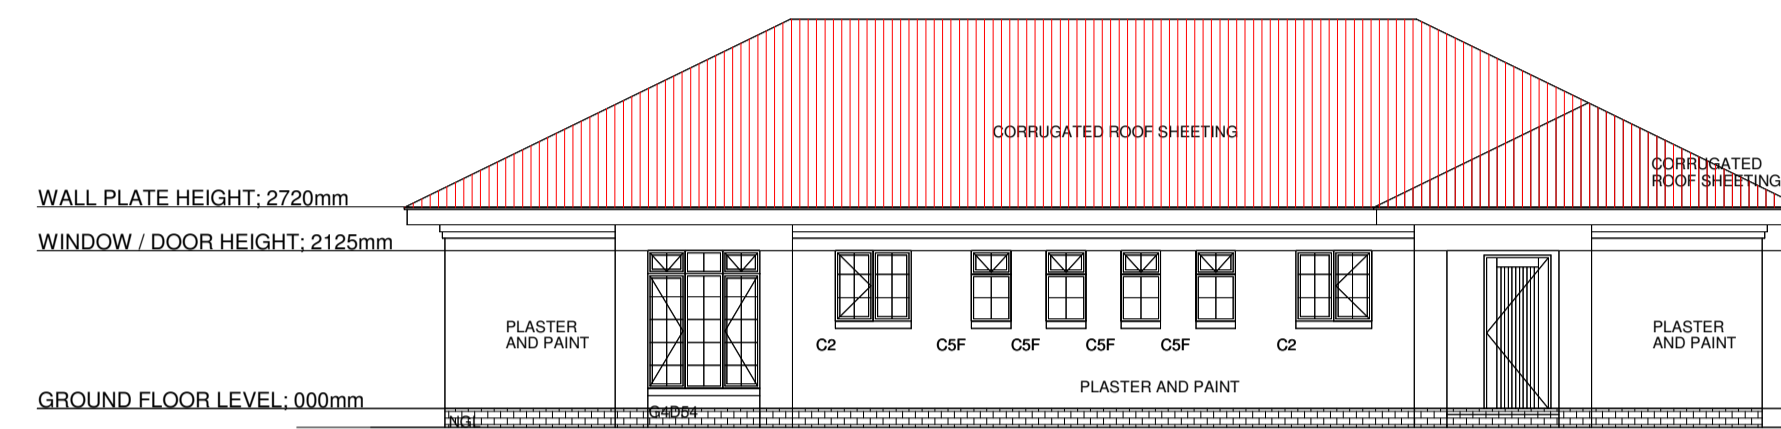


BACK ELEVATION
SCALE 1:100

DOOR SCHEDULE	DOOR HEIGHT		FFL	
	1445	723, 723	813	813
DOOR NUMBER	D1	D2A	D2B	D3
QUANTITY	ONE (1)	FOUR (4)	TEN (10)	THREE (3)
FRAME	STANDARD 1.6mm PRESSED METAL FOR 220mm WALL - DOUBLE REBATE.	STANDARD 1.6mm PRESSED METAL FOR 220mm WALL - SINGLE REBATE.	STANDARD 1.6mm PRESSED METAL FOR 110mm WALL - SINGLE REBATE.	STANDARD 1.6mm PRESSED METAL FOR 220mm WALL - DOUBLE REBATE.
FRAME FINISH	FRAME SUPPLIED WITH ONE COAT RED OXIDE CHROMATE PRIMER TO SABS 909. PAINTED ON SITE WITH ONE COAT UNIVERSAL UNDERCOAT AND TWO COATS UNIVERSAL GLOSS ENAMEL COLOUR: WHITE.	FRAME SUPPLIED WITH ONE COAT RED OXIDE CHROMATE PRIMER TO SABS 909. PAINTED ON SITE WITH ONE COAT UNIVERSAL UNDERCOAT AND TWO COATS UNIVERSAL GLOSS ENAMEL COLOUR: WHITE.	FRAME SUPPLIED WITH ONE COAT RED OXIDE CHROMATE PRIMER TO SABS 909. PAINTED ON SITE WITH ONE COAT UNIVERSAL UNDERCOAT AND TWO COATS UNIVERSAL GLOSS ENAMEL COLOUR: WHITE.	FRAME SUPPLIED WITH ONE COAT RED OXIDE CHROMATE PRIMER TO SABS 909. PAINTED ON SITE WITH ONE COAT UNIVERSAL UNDERCOAT AND TWO COATS UNIVERSAL GLOSS ENAMEL COLOUR: WHITE.
DOOR	TWO X 2032 X 723 X 40mm MERANTI DOUBLE SIDED DOOR, TWO PANEL SOLID DOOR.	2032 X 813 X 40mm SEMI-SOLID DOOR WITH HARDBOARD FINISH ON BOTH SIDES, WITH TWO PANEL INPRINT.	2032 X 813 X 40mm SEMI-SOLID DOOR WITH HARDBOARD FINISH ON BOTH SIDES, WITH TWO PANEL INPRINT.	2032 X 813 X 40mm MERANTI DOUBLE SIDED DOOR, TWO PANEL SOLID DOOR.
DOOR FINISH	SUPPLIED WITH ONE COAT SEALER. LIGHTLY SAND DOWN IN THE DIRECTION OF THE GRAIN. APPLY TWO COATS MATT VARNISH TO ALL EXPOSED SIDES. COLOUR BY ARCHITECT.	PAINT WITH ONE COAT WOOD PRIMER, ONE COAT UNIVERSAL UNDERCOAT AND TWO COATS OF DULUX SILTHANE SILK. COLOUR BY ARCHITECT.	PAINT WITH ONE COAT WOOD PRIMER, ONE COAT UNIVERSAL UNDERCOAT AND TWO COATS OF DULUX SILTHANE SILK. COLOUR BY ARCHITECT.	SUPPLIED WITH ONE COAT SEALER. LIGHTLY SAND DOWN IN THE DIRECTION OF THE GRAIN. APPLY TWO COATS MATT VARNISH TO ALL EXPOSED SIDES. COLOUR BY ARCHITECT.
FITTINGS	LOCKS TO BE DONE BY SPECIALIST.	LOCKS TO BE DONE BY SPECIALIST.	LOCKS TO BE DONE BY SPECIALIST.	LOCKS TO BE DONE BY SPECIALIST.

WINDOW SCHEDULE	WINDOW HEIGHT		FFL			
	533	1022	1511	1511		
WINDOW NUMBER	CSF	C2	C4	G4C4	G4D54	W1
QUANTITY	FOUR (4)	TWO (2)	ONE (1)	SEVEN (7)	THREE (3)	ONE (1)
CATALOGUE NO.	DUROWIN C5F	DUROWIN C2	DUROWIN C4	DUROWIN G4C4	DUROWIN G4D54	PURPOSE MADE
FRAME	STANDARD FX7 STEEL WINDOW FRAME.	STANDARD FX7 STEEL WINDOW FRAME.	STANDARD FX7 STEEL WINDOW FRAME.	STANDARD FX7 STEEL WINDOW FRAME.	STANDARD FX7 STEEL WINDOW FRAME.	STANDARD ALUMINIUM WINDOW FRAME.
FRAME FINISH	FRAME SUPPLIED WITH ONE COAT RED OXIDE CHROMATE PRIMER TO SABS 909. PAINTED ON SITE WITH ONE COAT UNIVERSAL UNDERCOAT AND TWO COATS UNIVERSAL GLOSS ENAMEL COLOUR: WHITE.	FRAME SUPPLIED WITH ONE COAT RED OXIDE CHROMATE PRIMER TO SABS 909. PAINTED ON SITE WITH ONE COAT UNIVERSAL UNDERCOAT AND TWO COATS UNIVERSAL GLOSS ENAMEL COLOUR: WHITE.	FRAME SUPPLIED WITH ONE COAT RED OXIDE CHROMATE PRIMER TO SABS 909. PAINTED ON SITE WITH ONE COAT UNIVERSAL UNDERCOAT AND TWO COATS UNIVERSAL GLOSS ENAMEL COLOUR: WHITE.	FRAME SUPPLIED WITH ONE COAT RED OXIDE CHROMATE PRIMER TO SABS 909. PAINTED ON SITE WITH ONE COAT UNIVERSAL UNDERCOAT AND TWO COATS UNIVERSAL GLOSS ENAMEL COLOUR: WHITE.	FRAME SUPPLIED WITH ONE COAT RED OXIDE CHROMATE PRIMER TO SABS 909. PAINTED ON SITE WITH ONE COAT UNIVERSAL UNDERCOAT AND TWO COATS UNIVERSAL GLOSS ENAMEL COLOUR: WHITE.	WHITE POWDER COATED.
GLASS	WINDOW TO BE FITTED WITH 3mm OPAQUE GLASS.	WINDOW TO BE FITTED WITH 3mm OPAQUE GLASS.	WINDOW TO BE FITTED WITH 3mm OPAQUE GLASS.	WINDOW TO BE FITTED WITH 3mm CLEAR GLASS.	WINDOW TO BE FITTED WITH 3mm CLEAR GLASS.	WINDOW TO BE FITTED WITH 6.38mm CLEAR SAFETY GLASS.
SECURITY	25 X 3mm FLAT BAR BURGULAR PROOFING TO BE FITTED ON ALL OPENERS.	25 X 3mm FLAT BAR BURGULAR PROOFING TO BE FITTED ON ALL OPENERS.	25 X 3mm FLAT BAR BURGULAR PROOFING TO BE FITTED ON ALL OPENERS.	25 X 3mm FLAT BAR BURGULAR PROOFING TO BE FITTED ON ALL OPENERS.	25 X 3mm FLAT BAR BURGULAR PROOFING TO BE FITTED ON ALL OPENERS.	-
FITTINGS	STANDARD BRASS STAYS & HANDLES AS SUPPLIED BY MANUFACTURER.	STANDARD BRASS STAYS & HANDLES AS SUPPLIED BY MANUFACTURER.	STANDARD BRASS STAYS & HANDLES AS SUPPLIED BY MANUFACTURER.	STANDARD BRASS STAYS & HANDLES AS SUPPLIED BY MANUFACTURER.	STANDARD BRASS STAYS & HANDLES AS SUPPLIED BY MANUFACTURER.	PROVIDE ALUMINIUM SPEAK THRU GRILL WITH HOLE IN GLASS PANEL.

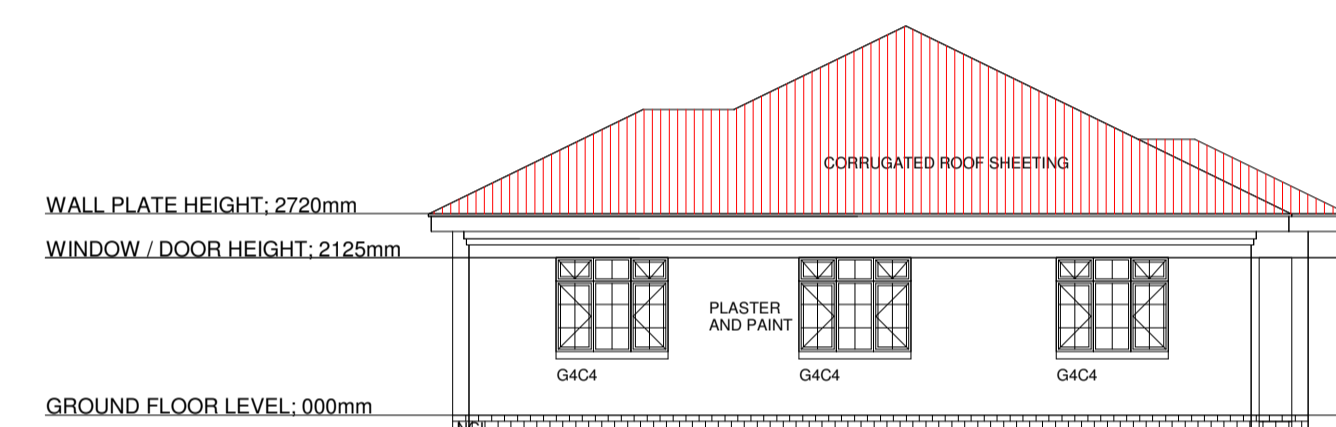

SIDE A ELEVATION
SCALE 1:100

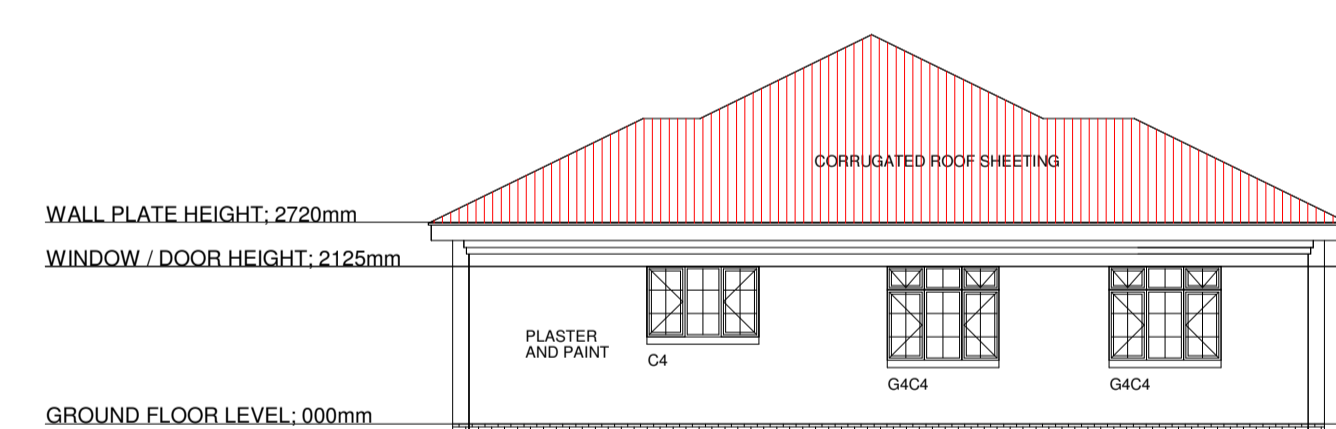

SIDE B ELEVATION
SCALE 1:100

REVISION

NO.	DATE	DESCRIPTION

NOTES

BLOBERG MUNICIPALITY
 PO Box 1593, Senwabarwana
 Tel: 015 505 7100
 Fax: 015 505 0568 / 0296
 Email: Mtsokolo@blouberg.gov.za

CLIENT

DIKGABO CONSULTING ENGINEERS
 PO Box 1365, Gallo Manor, 2052
 Tel: 011 656 4075
 Fax: 086 550 7497
 Email: floyd@dikgabo.co.za

ENGINEER

DESIGN	PJ BOTHA
REG. NO.	5508
SIGNATURE	
DATE	
DRAWN BY	J KIRKLAND
ENGINEER	F M RAKAU
REG. NO.	20070023
SIGNATURE	
DATE	
CLIENT	
SIGNATURE	DATE

PROJECT		TOWERFONTEIN CRÉCHE
DRAWING TITLE		WORKING DRAWINGS
DATE	OCTOBER 2019	
SCALE	AS SHOWN	
PROJECT NO.	BM07/18/19	
DRG NO.	BM07/18/19 - 003	
PRINT ISSUED	-	
File Path		